PROPOSED RESIDENTIAL 3 STOREY FLAT BUILDING 76B ST GEORGES CRESCENT, DRUMMOYNE NSW



	DRAWING SCHEDULE							
Sheet Number	Sheet Title							
C000	COVER SHEET							
C100	STORMWATER MANAGEMENT PLAN BASEMENT							
C101	STORMWATER MANAGEMENT PLAN GROUND 1							
C102	STORMWATER MANAGEMENT PLAN GROUND 2							
C103	STORMWATER MANAGEMENT PLAN SITE PLAN							
C200	DRAINAGE DETAILS							
C300	SEDIMENT AND EROSION CONTROL PLAN							

LOCALITY PLAN

IMAGE FROM GOOGLE MAP
100.11.2021

DIAL 1100

DIAL BEFORE YOU DIG CONTRACTOR TO CONFIRM LOCATION OF EXISTING SERVICES PRIOR TO COMMENCEMENT OF WORKS

ISSUE FOR DEVELOPMENT APPLICATION

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 ISSUE FOR DEVELOPMENT APPLICATION
 AU
 AU
 06.12.2021

 B
 ISSUE FOR DEVELOPMENT APPLICATION
 AU
 AU
 03.12.2021

 A
 ISSUE FOR DEVELOPMENT APPLICATION
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 12.11.2021

 Rev
 Description
 Eng
 Draft
 Date

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LEVEL 2, 52 ALBION STREET, SURRY HILLS, NSW 2010

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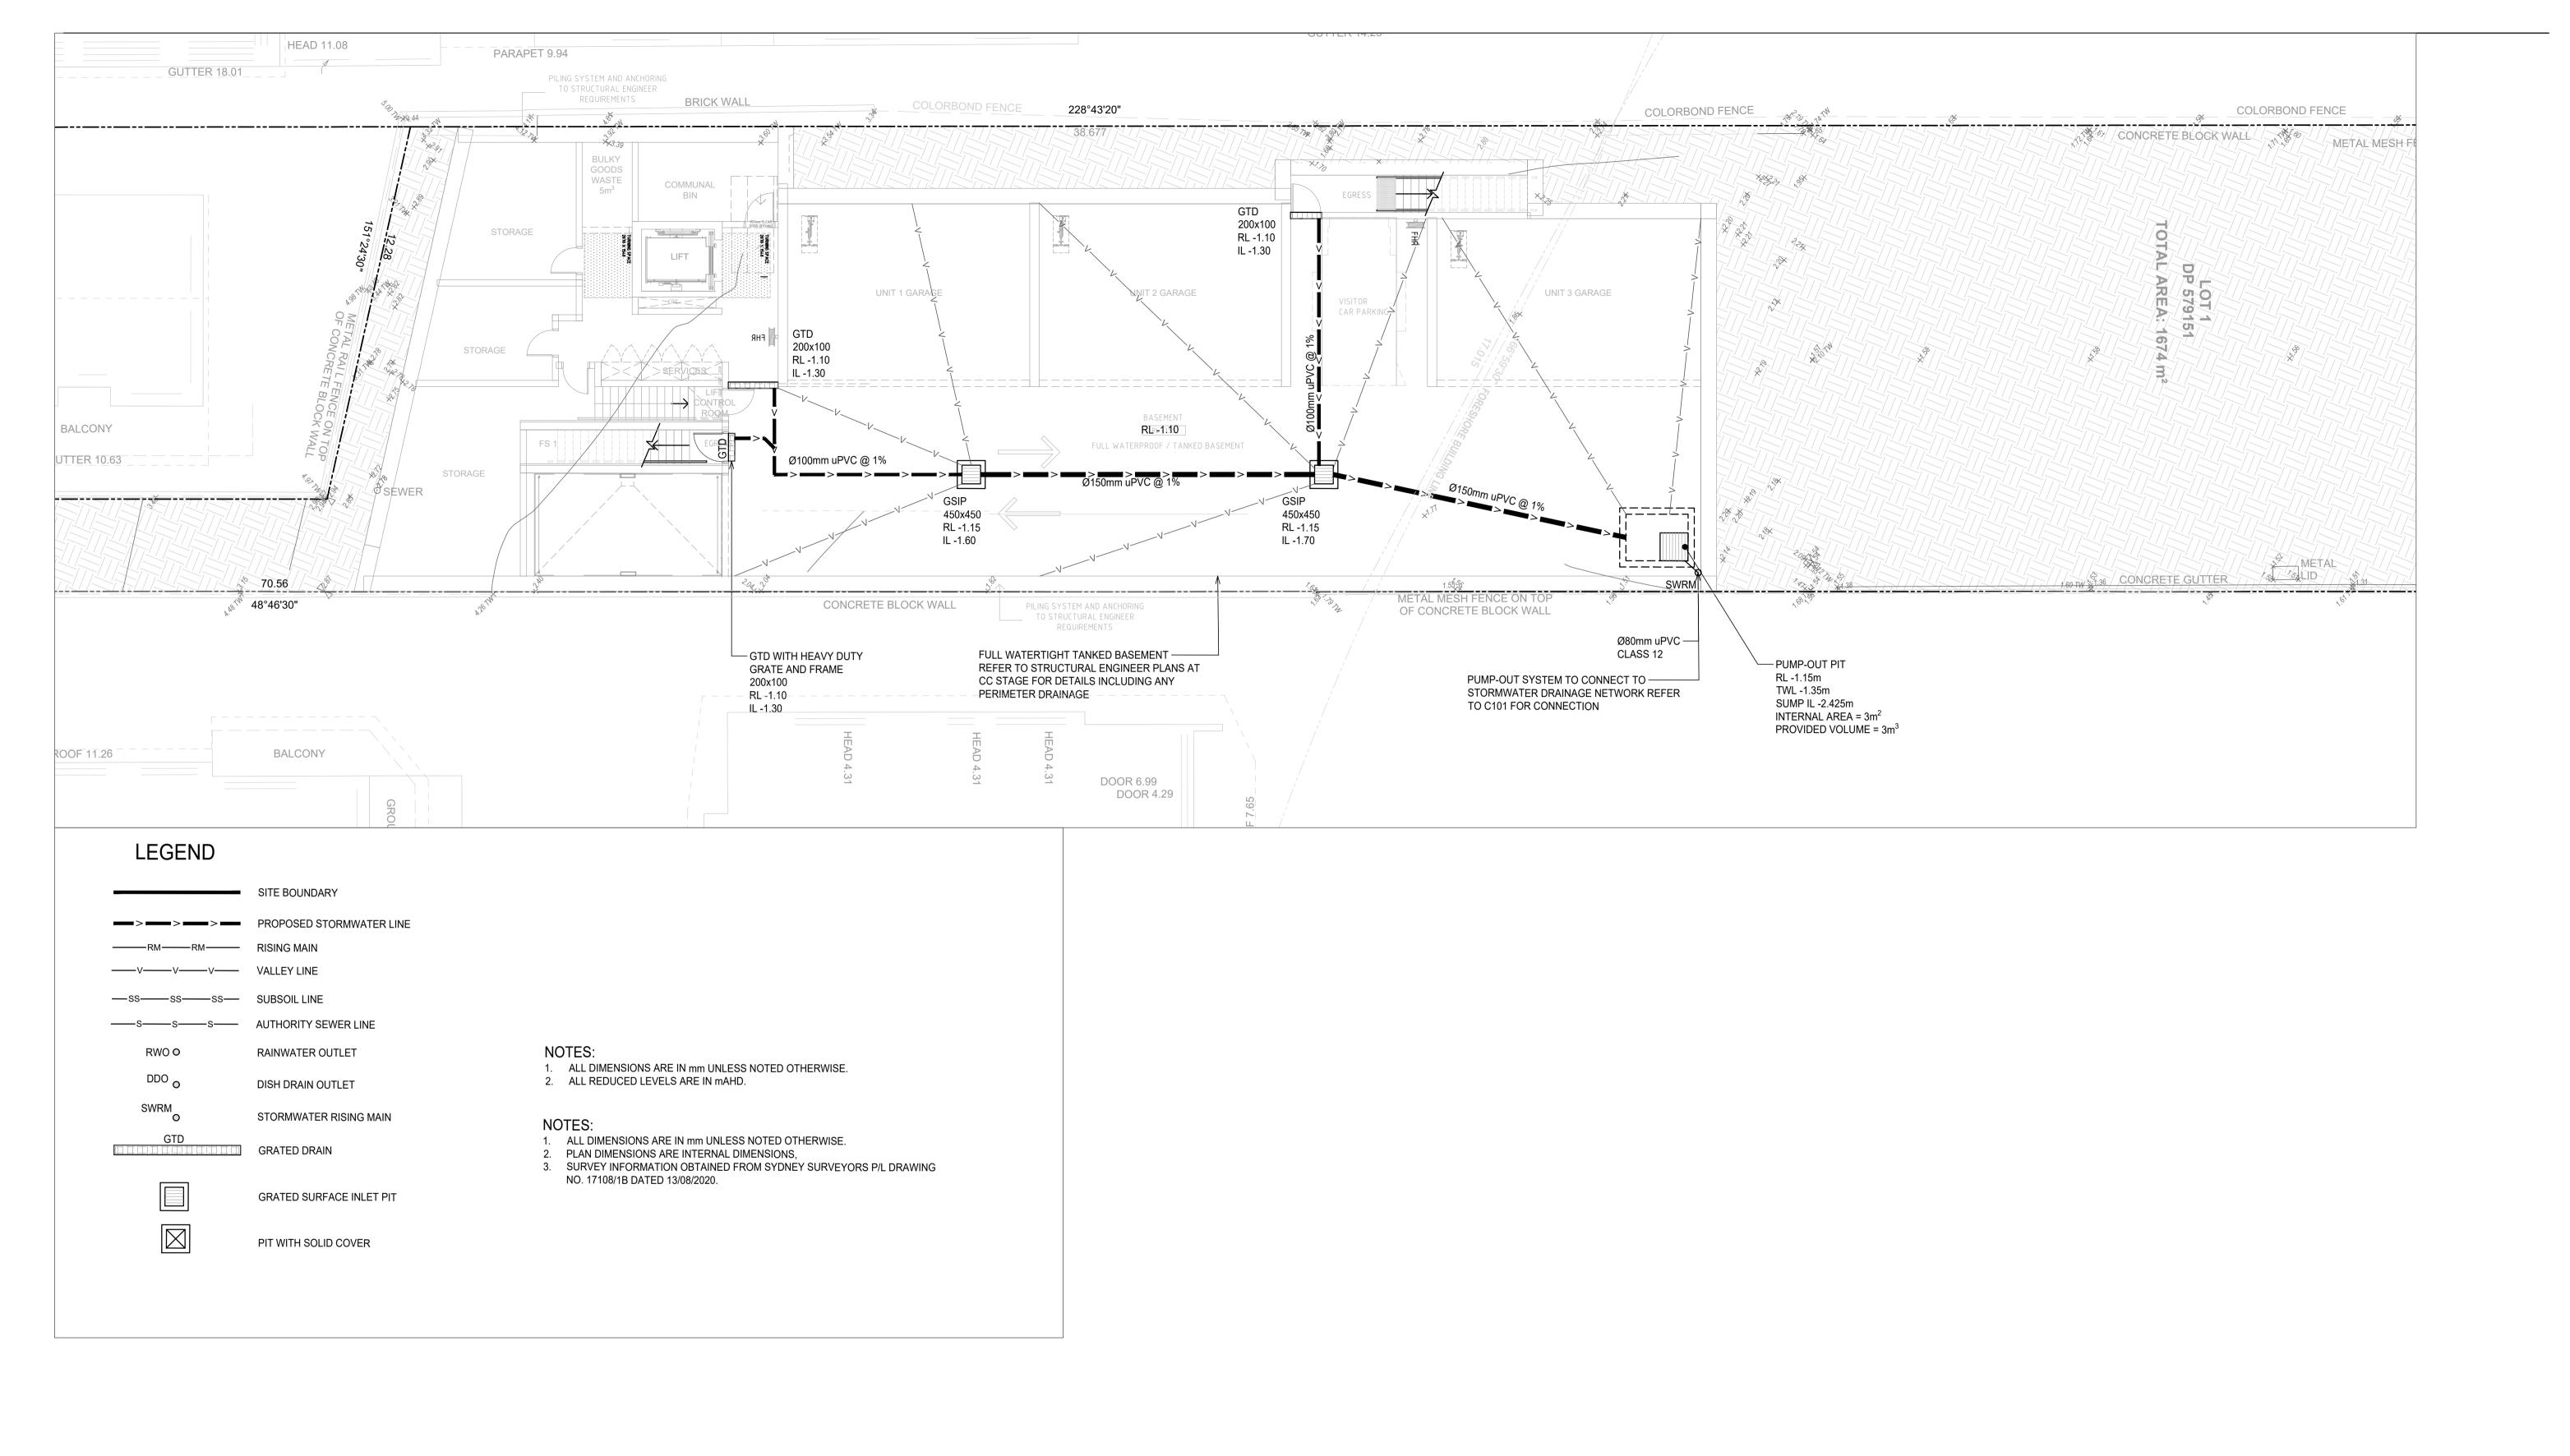


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Project	Scale at A1	Drawn	Approved
PROPOSED RESIDENTIAL 3 STOREY FLAT BUILDING	NTS	AU	SS
76B ST GEORGES CRESCENT DRUMMOYNE	N15	AU	33
Sheet Subject	Job No	Drawing No	Revision
COVER SHEET	200709	C000	С



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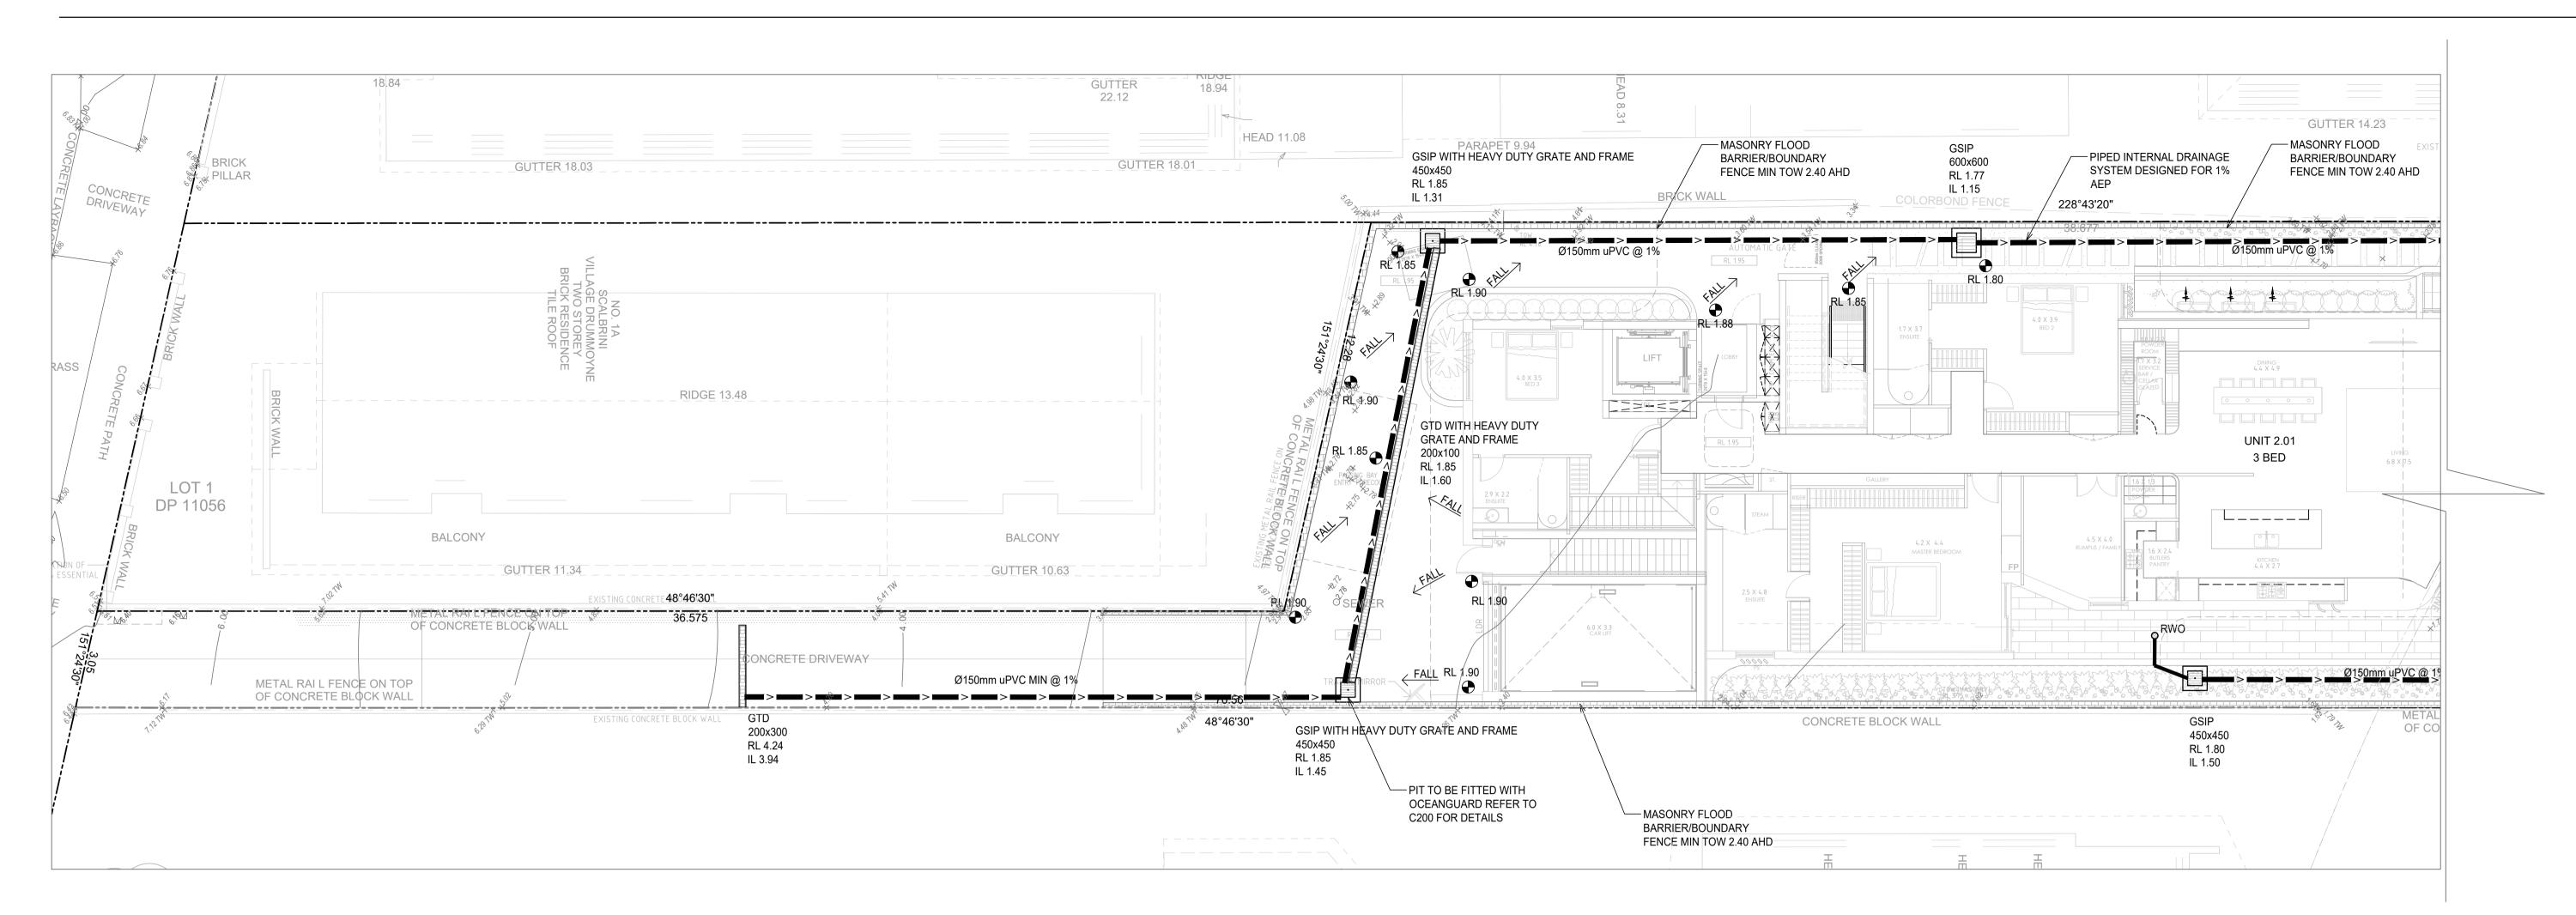
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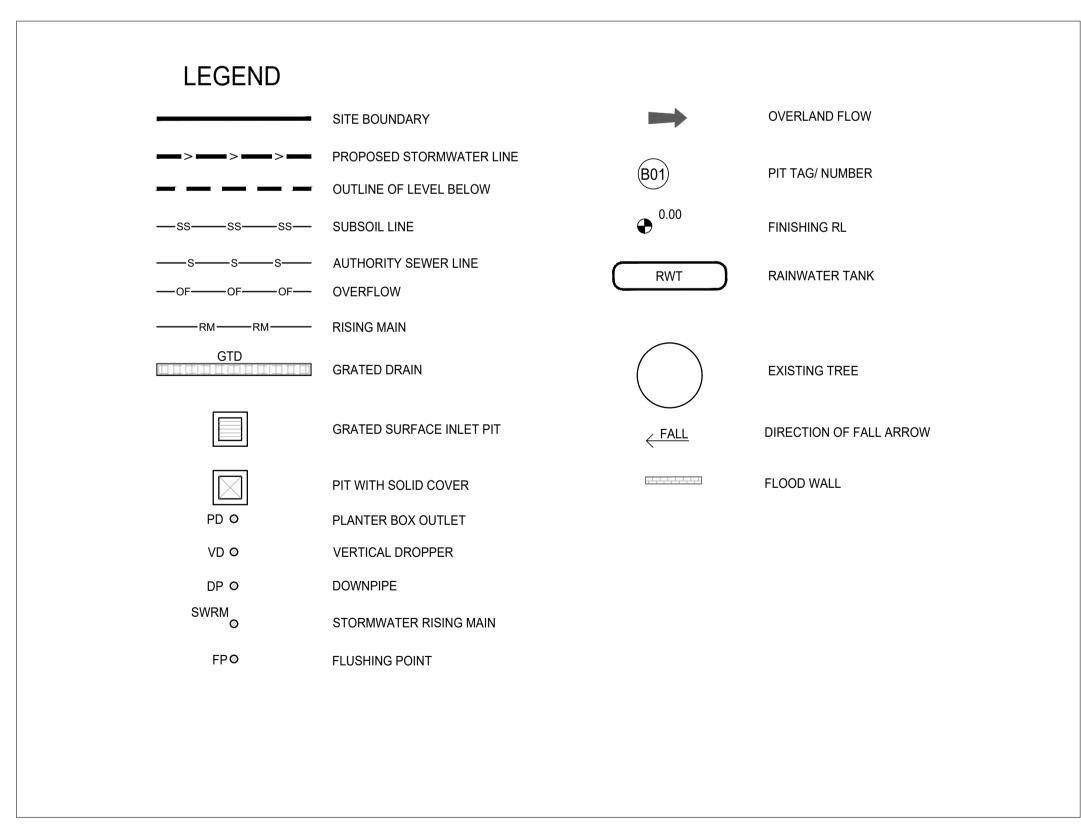
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	1:100	AU	SS
Sheet Subject STORMWATER MANAGEMENT PLAN BASEMENT	Job No 200709	Drawing No C100	Revision







NOTES:
ALL ROOF DRAINAGE TO BE SIZED FOR
1% AEP TO BE DETAILED BY HYDRAULIC
ENGINEER AT CC STAGE.

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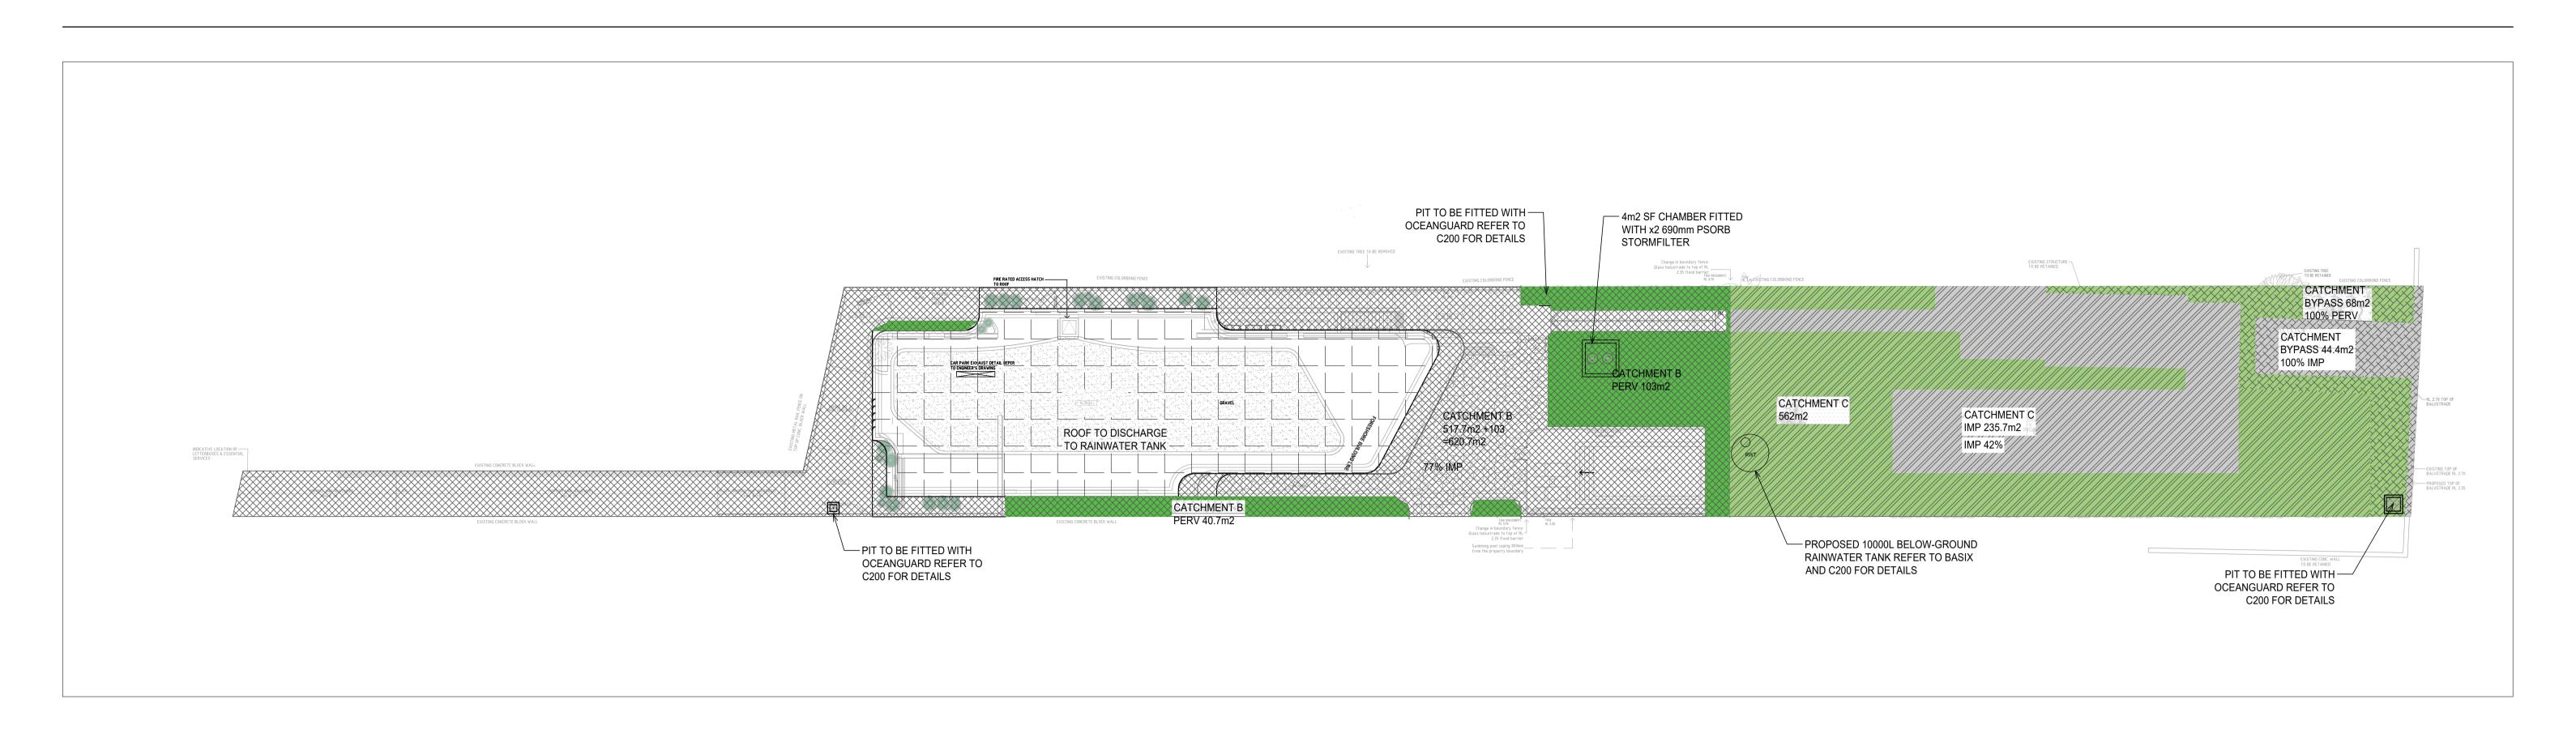


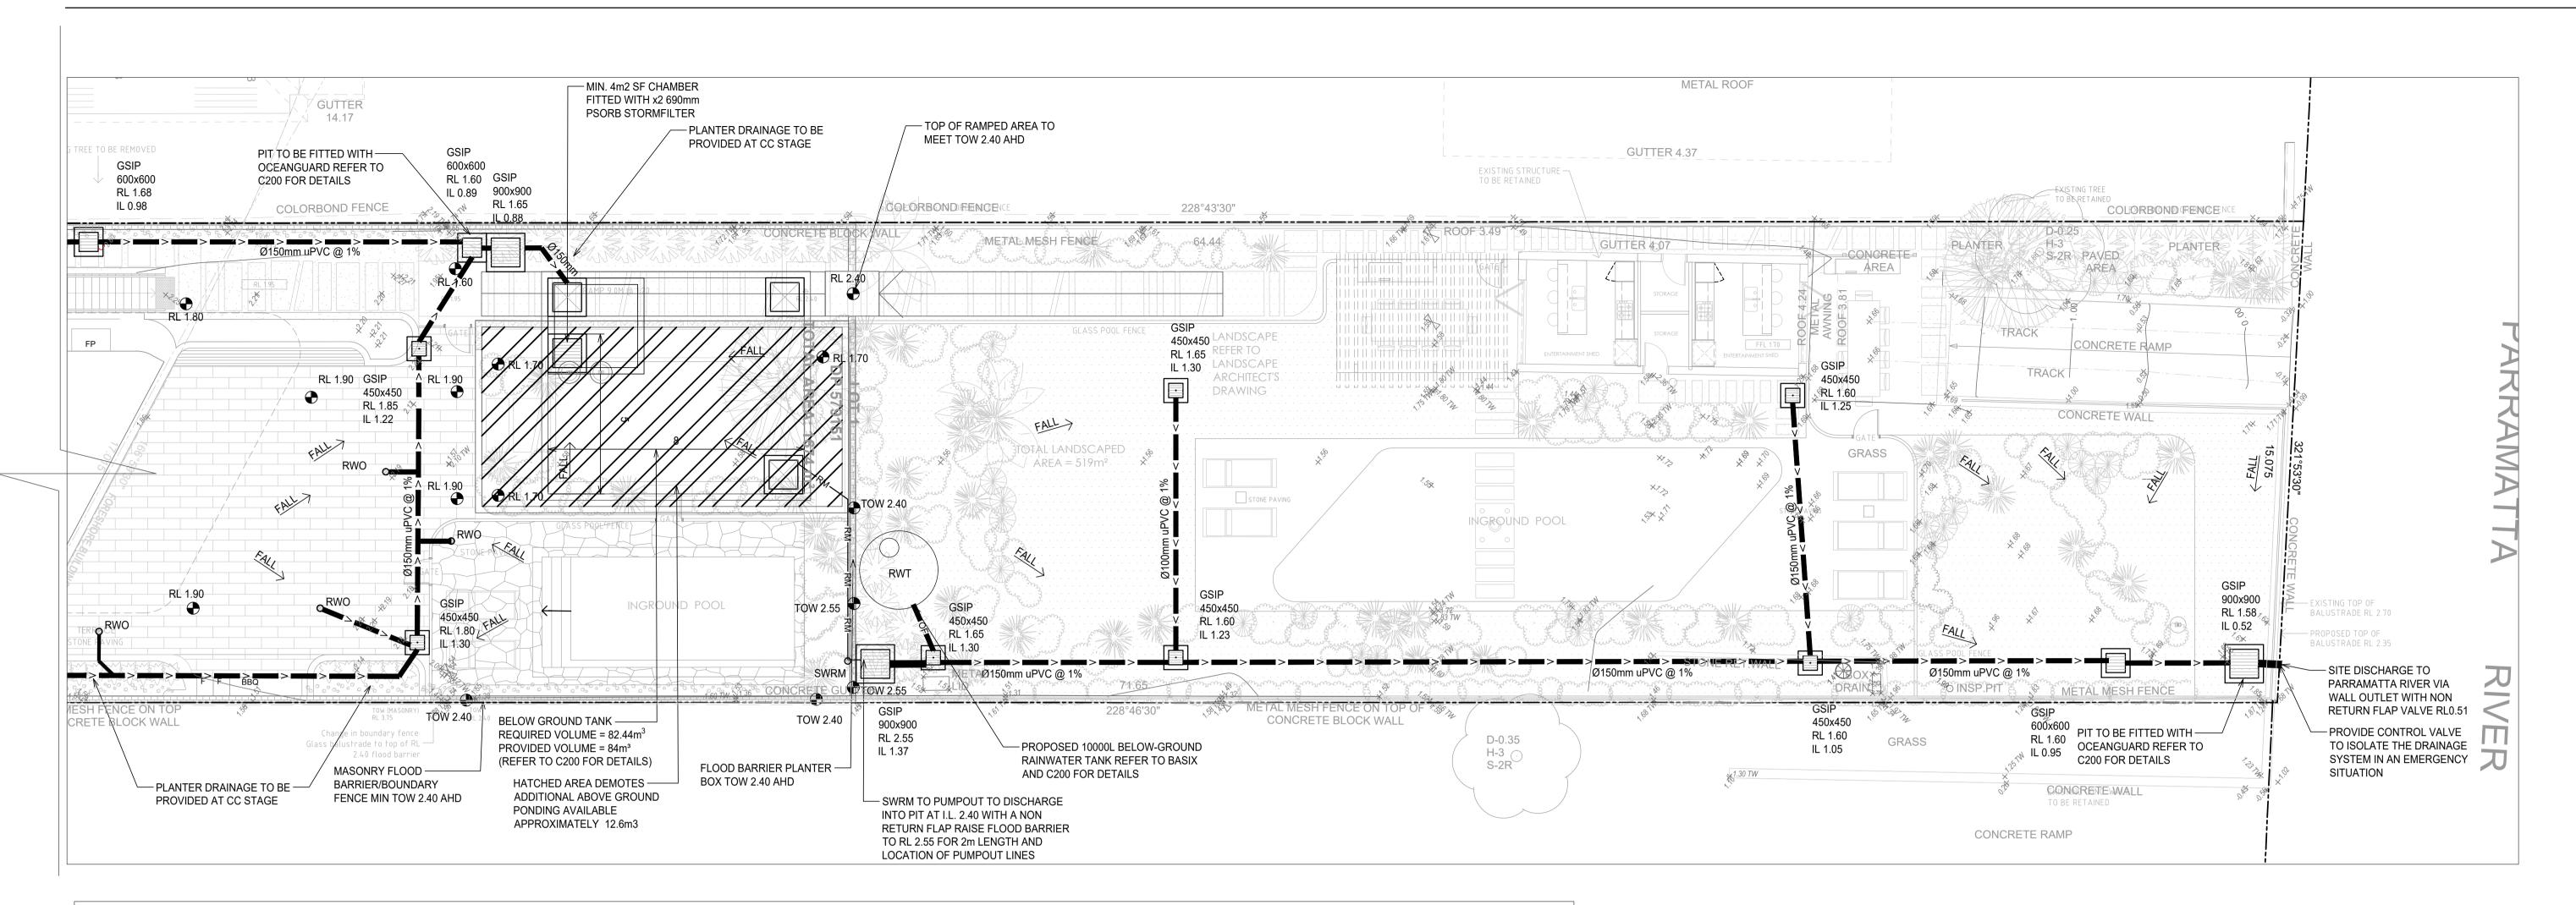


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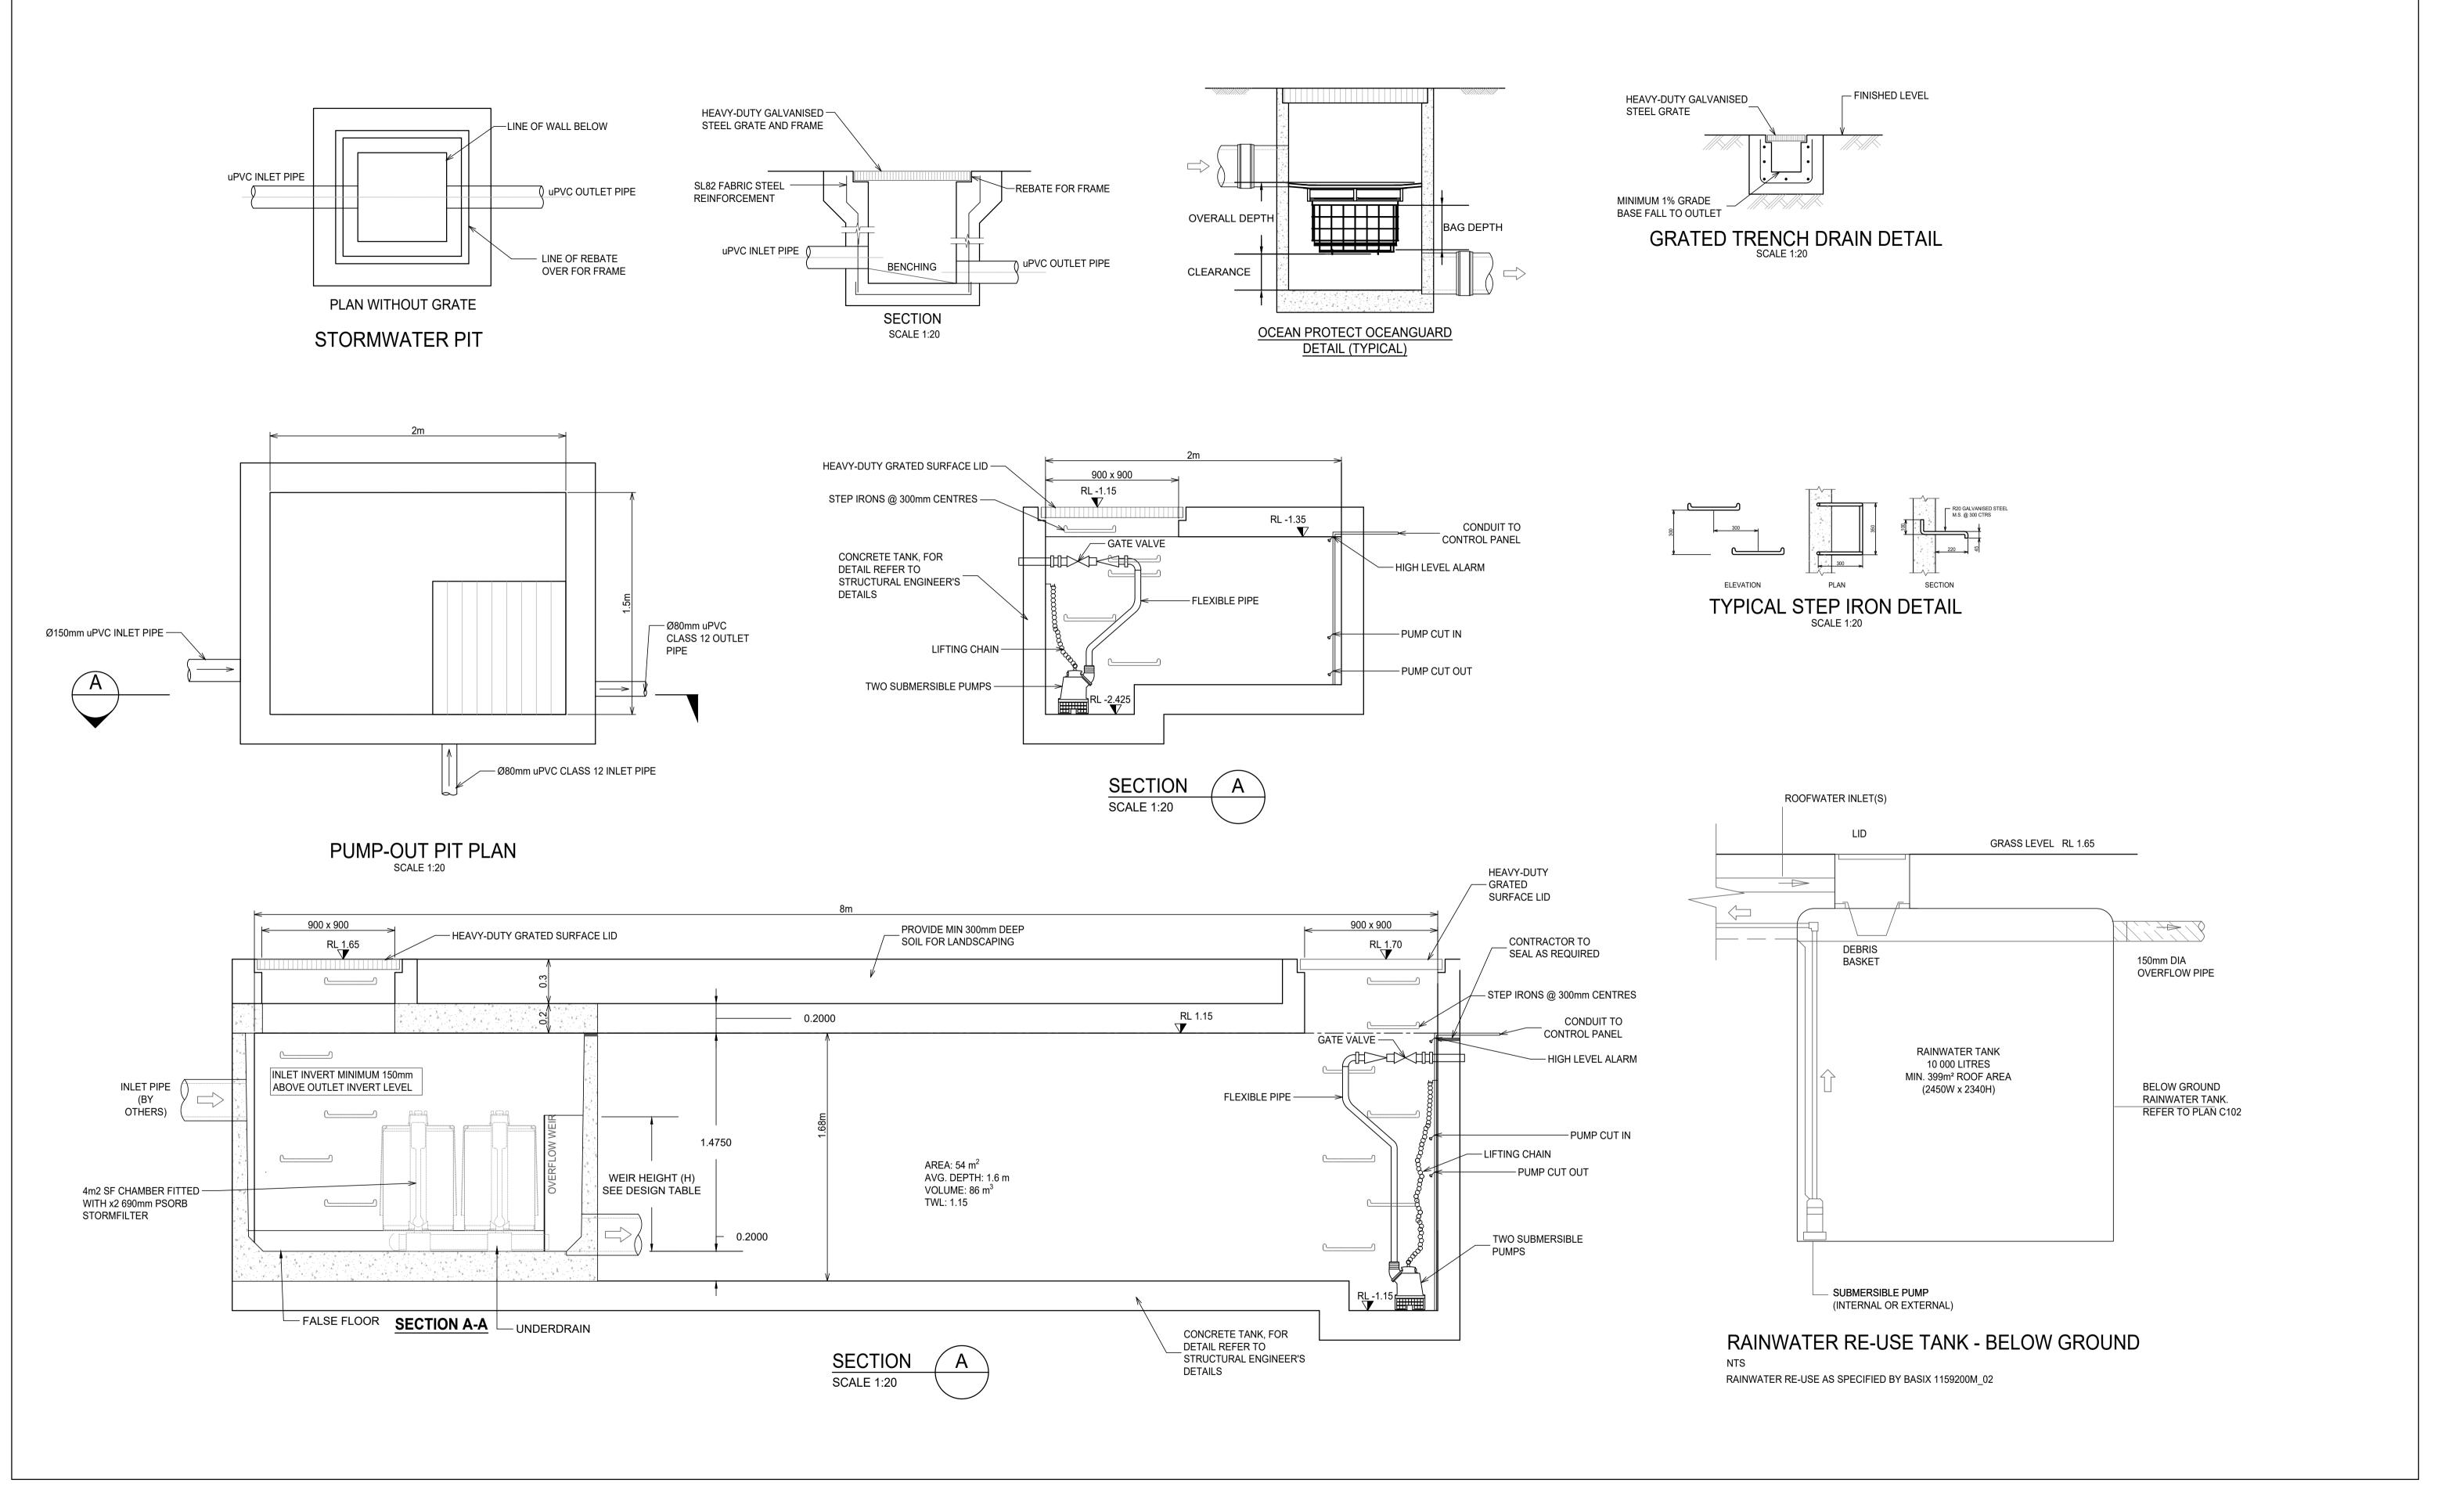

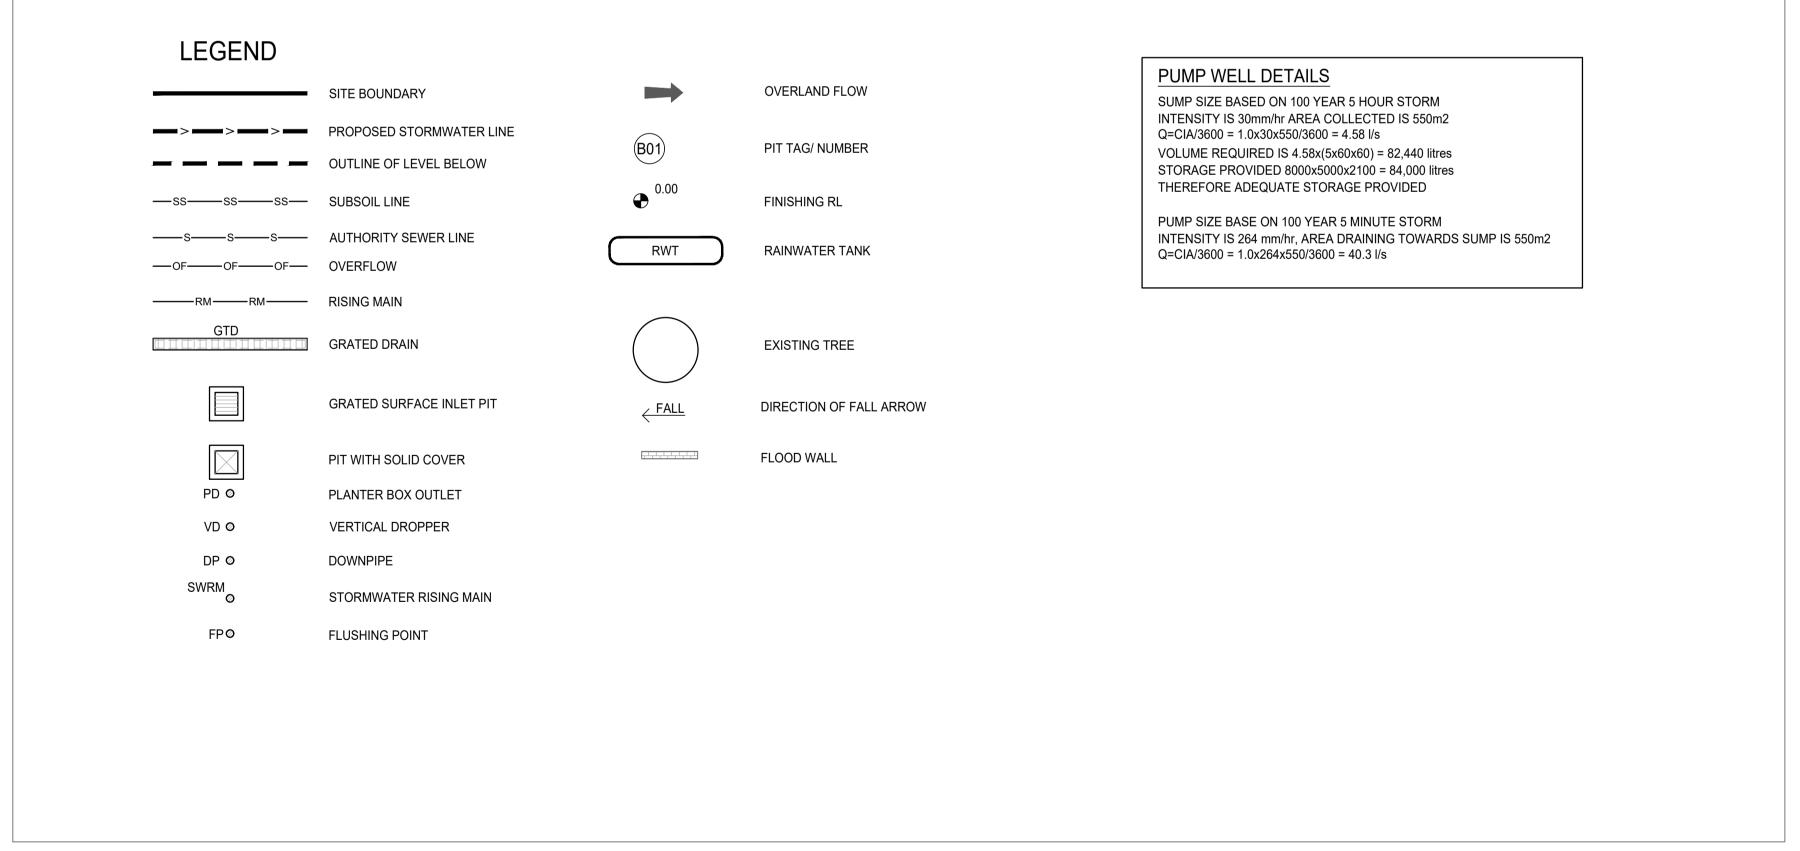
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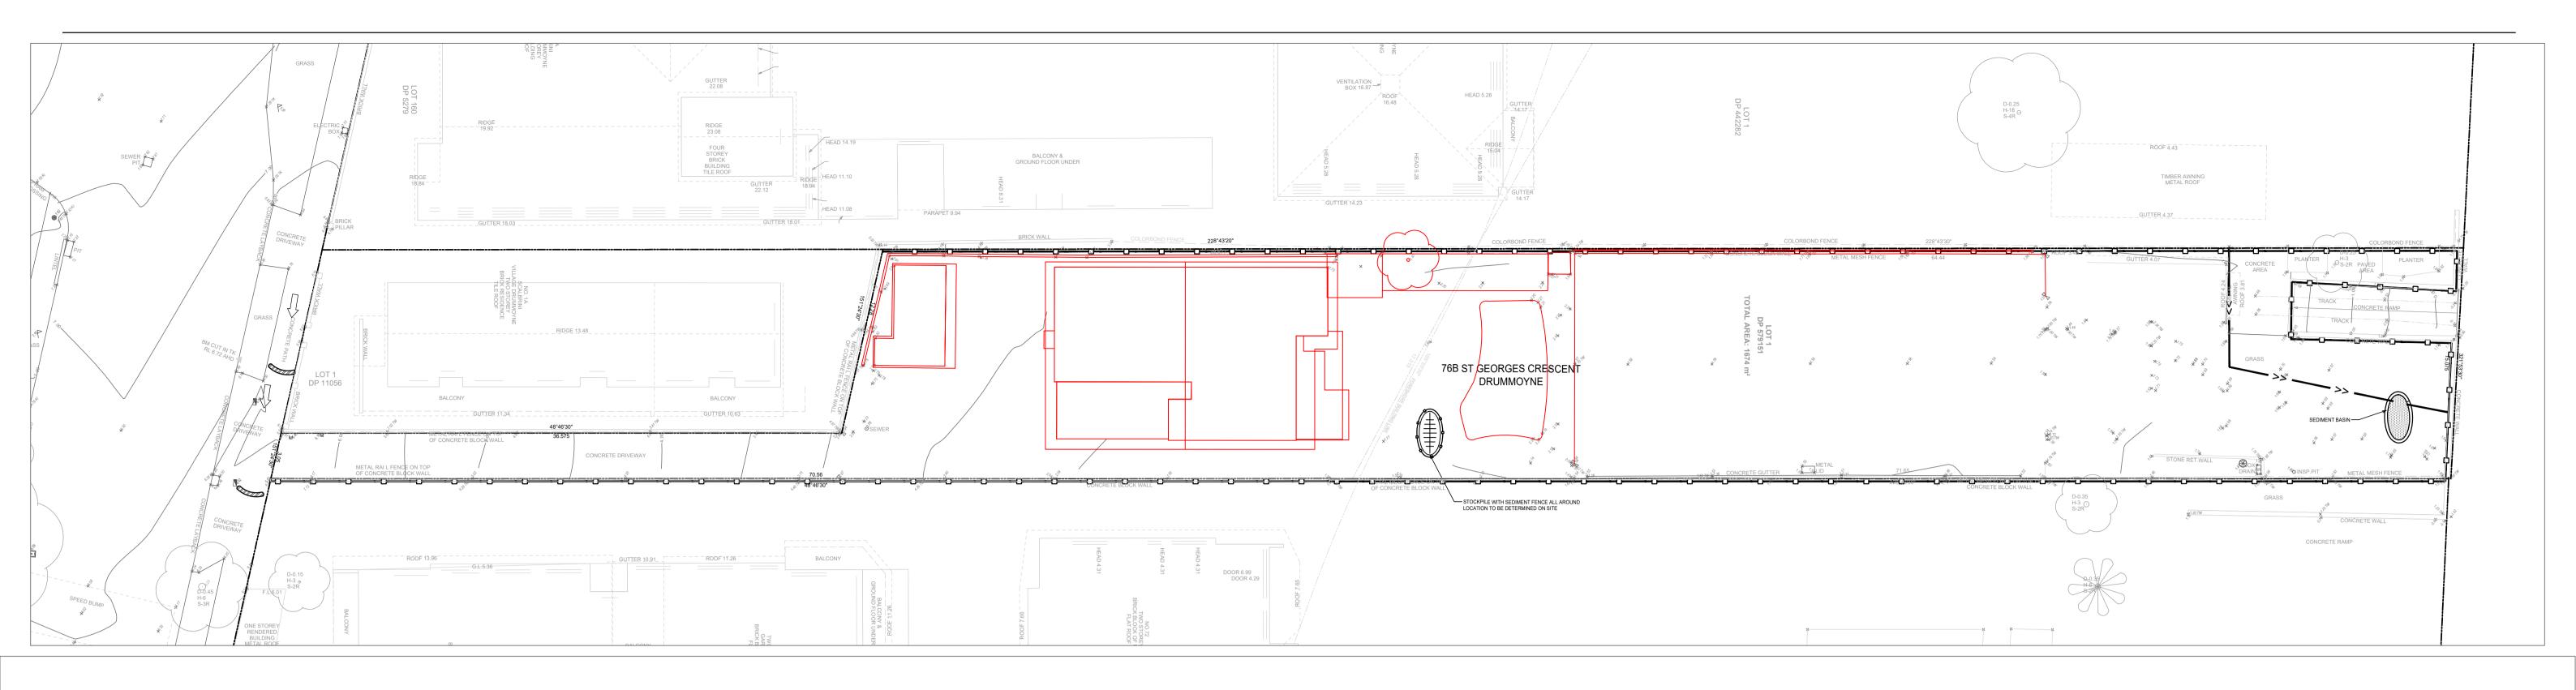
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Sheet Subject	Job No	Drawing No	Revision
STORM MANAGEMENT PLAN SITE AND ROOF	200709	C103	С



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LEGEND

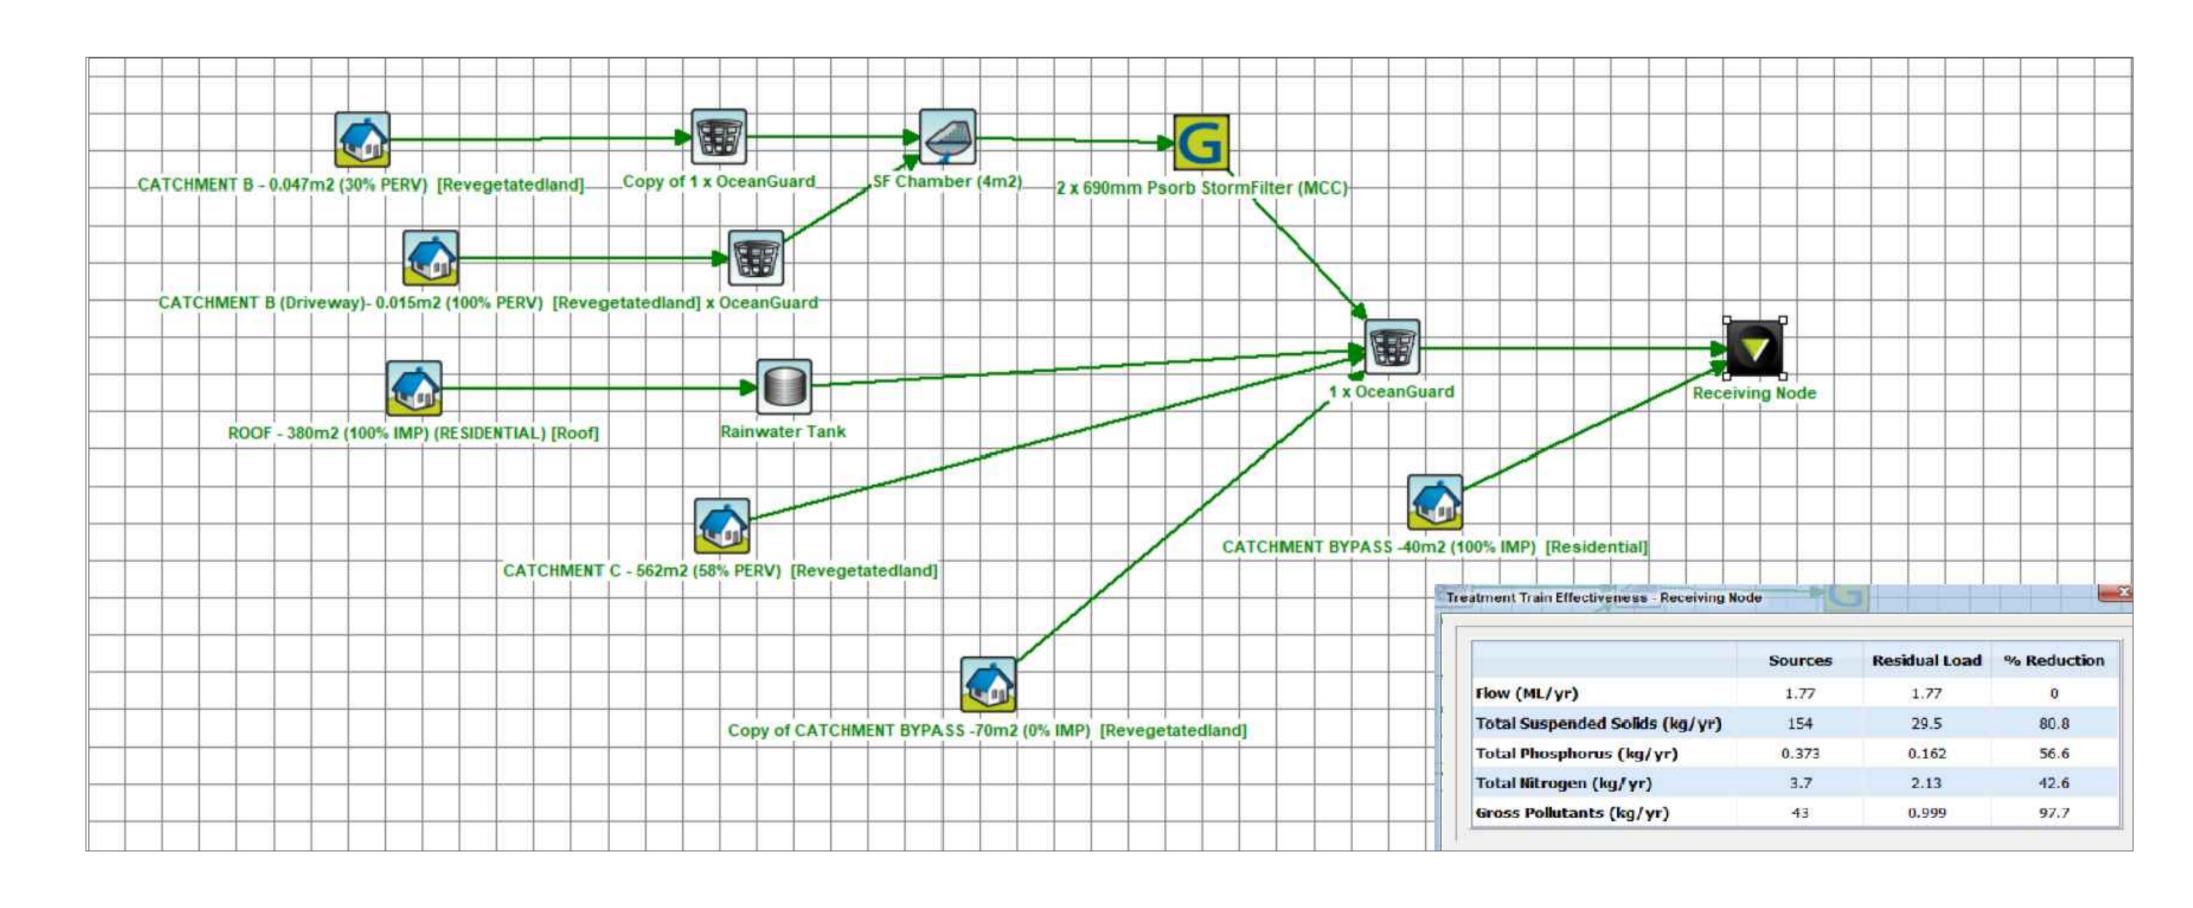----- SITE BOUNDARY

SEDIMENT FENCE

TEMPORARY CATCH DRAIN

TEMPORARY DRAINAGE PIPE

EXISTING STRUCTURES TO BE DEMOLISHED

FLOW DIRECTION

SAND BAG

PROPOSED STABILISED SITE ACCESS

1. PROVIDE THREE LAYERS OF SANDBAGS WITH

THEIR ENDS OVERLAPPED AND ALSO

2. CREATE A GAP IN THE SANDBAGS TO ACT AS

3. SANDBAG BARRIER TO BE MIN. 2m FROM THE

INLET AND EXTEND MIN. 0.9m OUT FROM THE KERB.


OVERLAPPING ONTO THE KERB.

A SPILLWAY.

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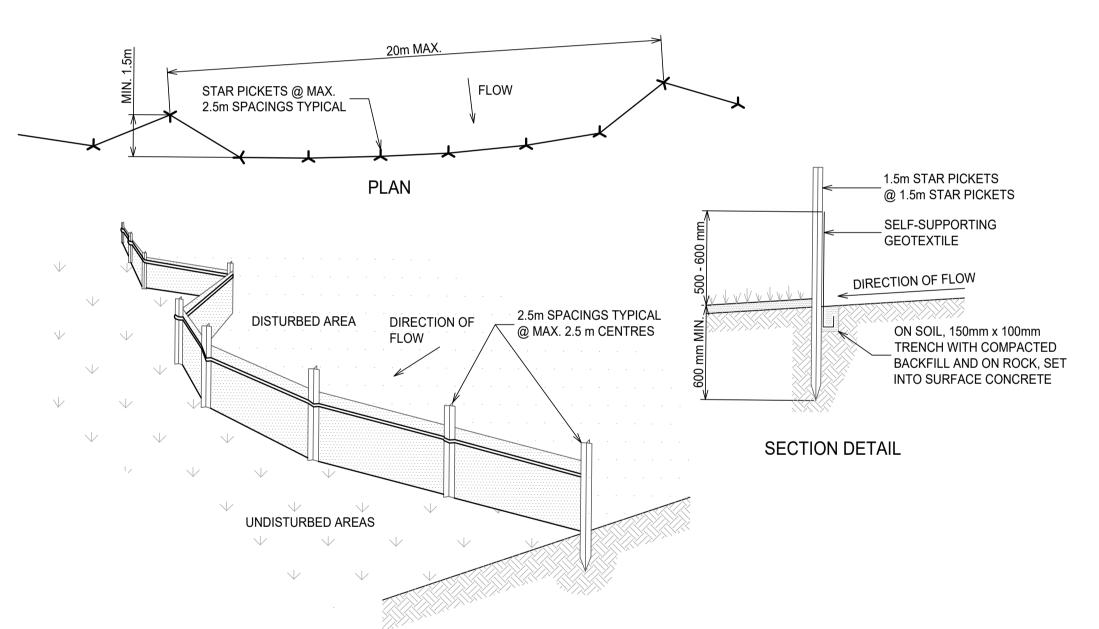
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SEDIMENT FENCE CONSTRUCTION NOTES:

- CONSTRUCT SEDIMENT FENCES AS CLOSE AS POSSIBLE TO BEING PARALLEL TO THE CONTOURS OF THE SITE, BUT WITH SMALL RETURNS AS SHOWN IN THE DRAWING TO LIMIT THE CATCHMENT AREA OF ANY ONE SECTION. THE CATCHMENT AREA SHOULD BE SMALL ENOUGH TO LIMIT WATER FLOW IF CONCENTRATED AT ONE POINT TO 50 LITRES PER SECOND IN THE DESIGN STORM EVENT, USUALLY THE 10-YEAR EVENT.
- 2. CUT A 150 mm DEEP TRENCH ALONG THE UPSLOPE LINE OF THE FENCE FOR THE BOTTOM OF THE FABRIC TO BE ENTRENCHED.
- 3. DRIVE 1.5 m LONG STAR PICKETS INTO GROUND @ 2.5 m INTERVALS (MAX.) AT THE DOWNSLOPE EDGE OF THE TRENCH. ENSURE ANY STAR PICKETS ARE FITTED WITH SAFETY CAPS.
- 4. FIX SELF-SUPPORTING GEOTEXTILE TO THE UPSLOPE SIDE OF THE POSTS ENSURING IT GOES TO THE BASE OF THE TRENCH. FIX THE GEOTEXTILE WITH WIRE TIES OR AS RECOMMENDED BY THE MANUFACTURER. ONLY USE GEOTEXTILE SPECIFICALLY PRODUCED FOR SEDIMENT FENCING. THE USE OF SHADE CLOTH FOR THIS PURPOSE IS NOT SATISFACTORY.
- 5. JOIN SECTIONS OF FABRIC AT A SUPPORT POST WITH A 150 mm OVERLAP.
- 6. BACKFILL THE TRENCH OVER THE BASE OF THE FABRIC AND COMPACT IT THOROUGHLY OVER THE GEOTEXTILE.

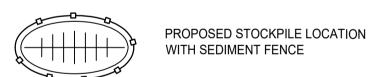

SEDIMENT FENCE SCALE N.T.S.

STABILISE STOCKPILE SURFACE - OVERFLOW PIT BERM IF REQUIRED - SETTING VOLUME SUBERSIBLE PUMP -RISING MAIN - STORAGE VOLUME **ABOVE GROUND** 0.6 m MIN.

SEDIMENT FENCE STOCKPILE CONSTRUCTION NOTES: 1. PLACE STOCKPILES MORE THAN 2 (PREFERABLY 5) METRES FROM EXISTING

VEGETATION, CONCENTRATED WATER FLOW, ROADS AND HAZARD AREAS. CONSTRUCT ON THE CONTOUR AS LOW, FLAT, ELONGATED MOUNDS. WHERE THERE IS SUFFICIENT AREA, TOPSOIL STOCKPILES SHALL BE LESS

THAN 2 METRES IN HEIGHT. WHERE THEY ARE TO BE PLACED FOR MORE THAN 10 DAYS, STABILISE FOLLOWING THE APPROVED E.S.C.P. OR S.W.M.P. TO REDUCE THE C-FACTOR

TO LESS THAN 0.10. 5. CONSTRUCT EARTH BANKS ON THE UPSLOPE SIDE TO DIVERT WATER AROUND STOCKPILES AND SEDIMENT FENCES 1 TO 2 METRES DOWNSLOPE.

STOCKPILES

SCALE N.T.S.

TYPICAL SEDIMENT BASIN

SCALE N.T.S.

GENERAL INSTRUCTIONS:

- 1. THIS SEDIMENT AND EROSION CONTROL WORKS FOR THE SITE SHALL BE CARRIED OUT IN ACCORDANCE WITH THE REQUIREMENTS OF "MANAGING URBAN STORMWATER - SOILS AND CONSTRUCTION, 4TH EDITION (2004)" BY LANDCOM.
- 2. AS REQUIRED BY COUNCIL, SEDIMENT CONTROL MEASURES WILL BE REQUIRED DURING THE CONSTRUCTION OF ALL DEVELOPMENTS/BUILDING WORKS. IT SHALL BE THE CONTRACTOR'S RESPONSIBILITY THAT THE WORKS ARE CARRIED OUT IN ACCORDANCE WITH THE SEDIMENT AND EROSION CONTROL PLAN AND COUNCIL'S REQUIREMENTS.
- 3. THE CONTRACTOR SHALL ENSURE THAT ALL SUBCONTRACTORS ARE INFORMED OF THEIR RESPONSIBILITIES IN MINIMISING THE POTENTIAL FOR SOIL EROSION AND POLLUTION TO DOWNSLOPE AREAS.
- 4. THE NON-DISTURBED PORTION OF THE CATCHMENT OUTSIDE OF OPERATING AREA IS TO BYPASS THE BASINS BY MEANS OF LINED CATCH DRAINS.
- WHERE PRACTICABLE, THE SOIL EROSION HAZARD SHALL BE KEPT AS LOW AS POSSIBLE. LIMITATIONS TO ACCESS ARE TO BE VIA STANLEY LANE UNLESS OTHERWISE APPROVED
- ENSURE THAT ALL DRAINS ARE OPERATING EFFECTIVELY AND SHALL MAKE ANY NECESSARY REPAIRS. REMOVE TRAPPED SEDIMENT WHERE THE CAPACITY OF THE TRAPPING DEVICE FALLS BELOW 60%.
- 7. CONSTRUCT ADDITIONAL EROSION OR SEDIMENT CONTROL WORKS AS MAY BE APPROPRIATE TO ENSURE THE PROTECTION OF DOWNSLOPE LANDS AND WATERWAYS.
- MAINTAIN EROSION AND SEDIMENT CONTROL MEASURES IN A FULLY FUNCTIONING CONDITION AT ALL TIMES UNTIL THE SITE IS REHABILITATED.
- REMOVE TEMPORARY SOIL CONSERVATION STRUCTURES AS THE LAST ACTIVITY IN THE REHABILITATION PROGRAM.

CONSTRUCTION SEQUENCE:

WORKS SHALL BE UNDERTAKEN IN THE FOLLOWING SEQUENCE:

- 1. INSTALL SEDIMENT FENCING AND CUT DRAINS TO MEET THE REQUIREMENTS OF THE SEDIMENT AND EROSION CONTROL PLAN. WASTE COLLECTION BINS SHALL BE INSTALLED ADJACENT TO SITE OFFICE.
- 2. CONSTRUCT STABILISED SITE ACCESS IN ACCORDANCE WITH COUNCIL'S REQUIREMENTS.
- REDIRECT CLEAN WATER AROUND THE CONSTRUCTION SITE.
- INSTALL SEDIMENT CONTROL PROTECTION MEASURES AT ALL NATURAL AND MAN-MADE DRAINAGE STRUCTURES. MAINTAIN UNTIL ALL THE DISTURBED AREAS ARE STABILISED.
- CLEAR AND STRIP THE WORK AREAS. MINIMISE THE DAMAGE TO THE GRASS AND LOW GROUND COVER OF NON-DISTURBED AREAS.
- ANY DISTURBED AREAS, OTHER THAN BUILDING PAD AREAS, SHALL IMMEDIATELY BE COVERED WITH SITE TOPSOIL WITHIN 7 DAYS OF CLEARING. BUILDING PAD AREAS SHALL BE COVERED WITH BITUMEN EMULSION AS SPECIFIED.

GULLY INLET SANDBAG PROTECTION DETAIL SCALE N.T.S.

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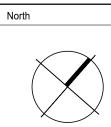
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76B ST GEORGES CRESCENT DRUMMOYNE	1:200	AU	33
SEDIMENT AND EROSION	Job No	Drawing No	Revision
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